

 REC
 REVISED ZONING INFO & EASEMENT

 RLC
 INCREASED PIPE SIZES, ADDED FLOW CALCS.
 JEM RLC REVISED PER ENGINEERS REPORT DATED 10/12/06, REV. 10/26/06 JEM RLC REVISED DWELLING


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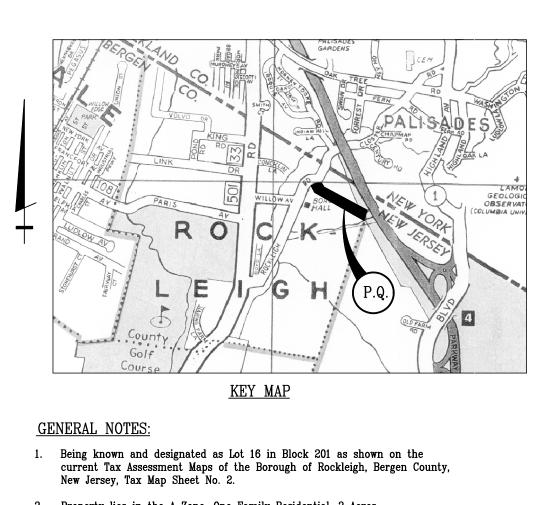
100' 200' 300' 400' GRAPHIC SCALE	C	COSTA ENGINEERING CORPORATION PROFESSIONAL ENGINEERS • SURVEYORS • PLANNERS State of New Jersey Certificate of Authorization No. GA 276726. 325 So. RIVER STREET - SUITE 302, HACKENSACK, N.J. 07601 TEL (201) 487-0015 FAX (201) 487-5122
COSTA N.J. LIC. NO. 34702 & 4639	DRAWING TITLE:	AREA MAP & COVER SHEET
DFESSIONAL ENGINEER AND PLANNER	PROJECT NAME:	32 ROCKLEIGH ROAD, LLC
DATE: 6-22-06		BLOCK 201 LOT 16
A. KRUEGEL N.J. LIC. NO. 24202	LOCATION:	BOROUGH OF ROCKLEIGH
PROFESSIONAL LAND SURVEYOR		BERGEN COUNTY, NEW JERSEY
DATE:		PROJ. NO. 05 1697 SCALE: 1"=100' DRAWN BY: JMM 6

SHEET INDEX

I
2
3
3 4 5
6

AREA MAP & COVER SHEET SITE GRADING PLAN AND SEPTIC DESIGN CONSTRUCTION AND SEPTIC DETAILS SOIL MOVEMENT SECTIONS SOIL EROSION AND SEDIMENT CONTROL PLAN SIGHT DISTANCE PROFILES



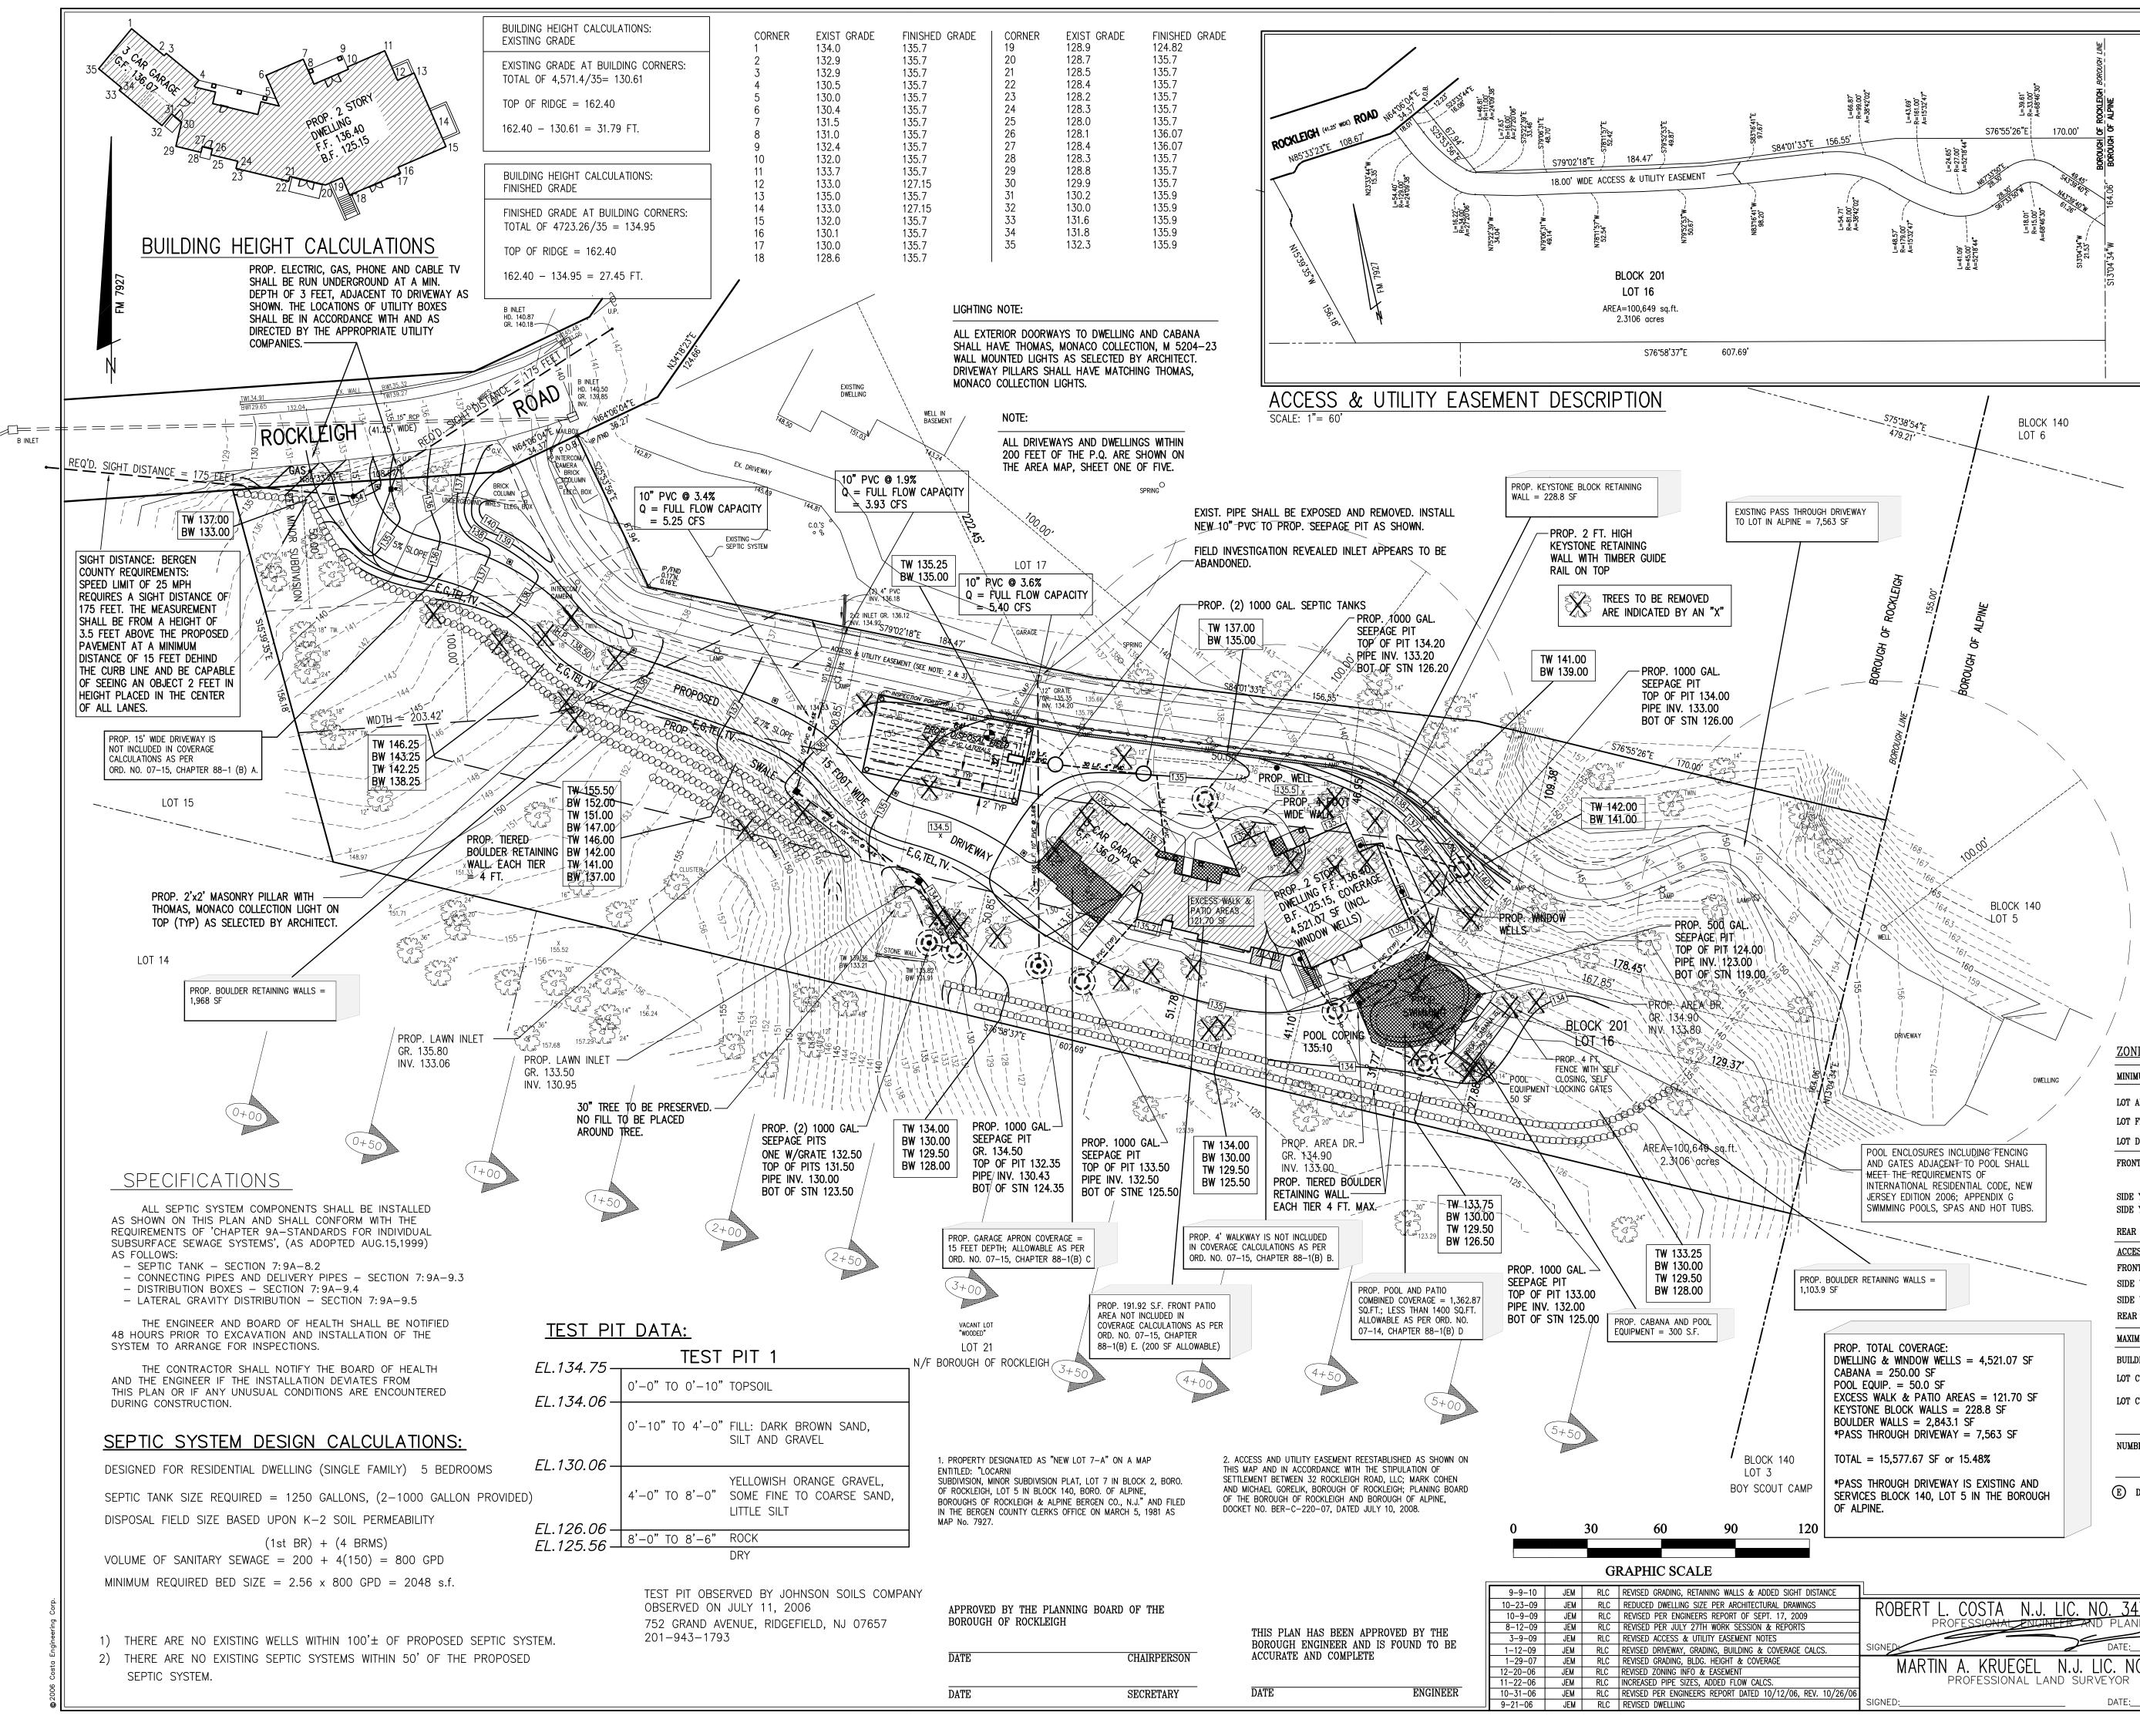

- Property lies in the A Zone, One Family Residential, 2 Acres.
 Area of lot: 100,649 S.F. or 2.3106 acres.
- 4. Elevations shown are based on N.G.V.D. 1929 Datum.
- 5. All construction to be in accordance with the Borough of Rockleigh Ordinances and/or Specifications.
- 6. Property owners: Mark Cohen 75 Oak Street
- 7. Applicant :
- c/o Alampi & De Marrais One University Plaza, Suite 404 Hackensack, New Jersey 07601

Norwood, New Jersey 07648

32 Rockleigh Road, LLC

- 8. The location and depths of all utilities shown are approximate. For their exact location and depths, the Contractor shall contact the respective utility companies at 1-800-272-1000. Prior to any construction contractor shall verify existing site conditions. If there are any conflicts with this plan the Engineer/Architect shall be notified before commencing construction. Contractors investigation shall include, but not be limited to, location and elevation of all underground utilities and structures, and clearances at crossings. Test holes may be necessary. Commencement of construction shall constitute acceptance by the contractor of this plan, conditions, and consequences thereof. Results of findings may necessitate adjustments to this plan.
- 9. All disturbed areas are to be stabilized during construction based on the requirements of the Essex County Soil Conservation District.
- 10. All utilities, including but not limited to, electric and telephone

service shall be installed underground.


- 11. All proposed roof leaders are to be tied into the on-site drainage system.
- Entire property falls outside of any flood plain areas as shown on the "Flood Insurance Rate Map, Bergen County, New Jersey, (all Jurisdictions) Panel 118 of 332 map no. 34003C0118G, last revised September 30, 2005.
- 13. Foundation drains and waterproofing as designed by Architect.
- 14. All roof drainage and foundation drainage must remain separated until their final destination.
- 15. This plan reflects conditions as of the drawing date and may not show
- current conditions. 16. Costa Engineering Corporation, State of New Jersey Certificate of
- Grading around proposed dwelling shall conform to the International Residential Code, New Jersey Edition, 2006, chapter 4, Section R401.


ZONING SCHEDULE: A ZONE, ONE FAMILY RESIDENTIAL


Authorization No. GA 276726.


MINIMUMS	REQUIRED	PROVIDED		
LOT AREA	2 ACRES	2.3106 ACRES (100,649 SF)		
LOT FRONTAGE	200 FEET	143.04 FEET E		
LOT DEPTH	200 FEET	671.42 FEET		
FRONT YARD	30% OF MEAN LOT DEPTH (NOT LESS THAN 75 FT. (NEED NOT EXCEED 100 FT.))	222.45 FEET		
SIDE YARD (1) SIDE YARD (2)	25% OF WIDTH (NOT LESS THAN 50 FT.) 25% OF WIDTH (NOT LESS THAN 50 FT.)	DWELLING 46.95 FEET (V) BASEMENT STAIRS 41.10 FEET (V)		
REAR YARD	25% OF DEPTH (NOT LESS THAN 50 FT.)	178.45 FEET		
ACCESSORY BUILDING: FRONT YARD SIDE YARD (1) SIDE YARD (2) REAR YARD MAXIMUMS BUILDING HEIGHT LOT COVERAGE (DWLG) LOT COVERAGE (TOTAL)	30% OF MEAN LOT DEPTH = 201.43 FEET WITHIN 25 FEET OF A SIDE PROPERTY LINE WITHIN 25 FEET OF A SIDE PROPERTY LINE WITHIN 25 FEET OF A REAR PROPERTY LINE REQUIRED 2-1/2 STYS. OR 28 FEET 4.5% OR (4,529.21 SF) 5% OR (5,032.49 SF)	379.21 FEET 27.88 FEET 109.38 FEET 129.37 FEET PROVIDED 31.79 FEET (V) 4.49% OR (4,521.07 SF) 15.48% OR (15,577.67 SF) (V)		
LOI COVERAGE (IOIAL)	(IF PASS THROU	JGH DRIVEWAY IS REMOVED FROM CALCS) WOULD BE 7.96% OR 8,014.67 SF)		
NUMBER OF DRIVEWAYS		TWO V FOR THE PROPOSED DWLG. & ONE PASS GH FOR THE ADJACENT LOT IN ALPINE)		
E denotes existing n	IONCONFORMITY (V) DENOTES VARIANCE REQUIRED			
	C COSTA ENGINE	ERING CORPORATION		

State of New Jersey Certificate of Authorization No. GA 276726. State of New Jersey Certificate of Authorization No. GA 276726. State of New Jersey Certificate of Authorization No. GA 276726. State of New Jersey Certificate of Authorization No. GA 276726. State of New Jersey Certificate of Authorization No. GA 276726. State of New Jersey Certificate of Authorization No. GA 276726. State of New Jersey Certificate of Authorization No. GA 276726. State of New Jersey Certificate of Authorization No. GA 276726. State of New Jersey Certificate of Authorization No. GA 276726. State of New Jersey Certificate of Authorization No. GA 276726. State of New Jersey Certificate of Authorization No. GA 276726. State of New Jersey Certificate of Authorization No. GA 276726. Black State of New Jersey Certificate of Authorization No. GA 276726. State of New Jersey Certificate of Authorization No. GA 276726. Project Name: Site GRADING PLAN & SEPTIC DESIGN Date: 6-22-06 Deck 201, LOT 16, 32 ROCKLEIGH ROAD	
PROFESSIONAL ENGINEER AND PLANNER PROJECT NAME: 32 ROCKLEIGH ROAD, LLC	
SIGNED: DATE: 6-22-06 LOCATION: BLOCK 201, LOT 16, 32 ROCKLEIGH ROAD	
MARTIN A. KRUEGEL N.J. LIC. NO. 24202 BOROUGH OF ROCKLEIGH	
PROFESSIONAL LAND SURVEYOR BERGEN COUNTY, NEW JERSEY	2
/26/06 SIGNED: PROJ. NO. 05-1697 SCALE: 1"= 30' DRAWN BY: JEM	6

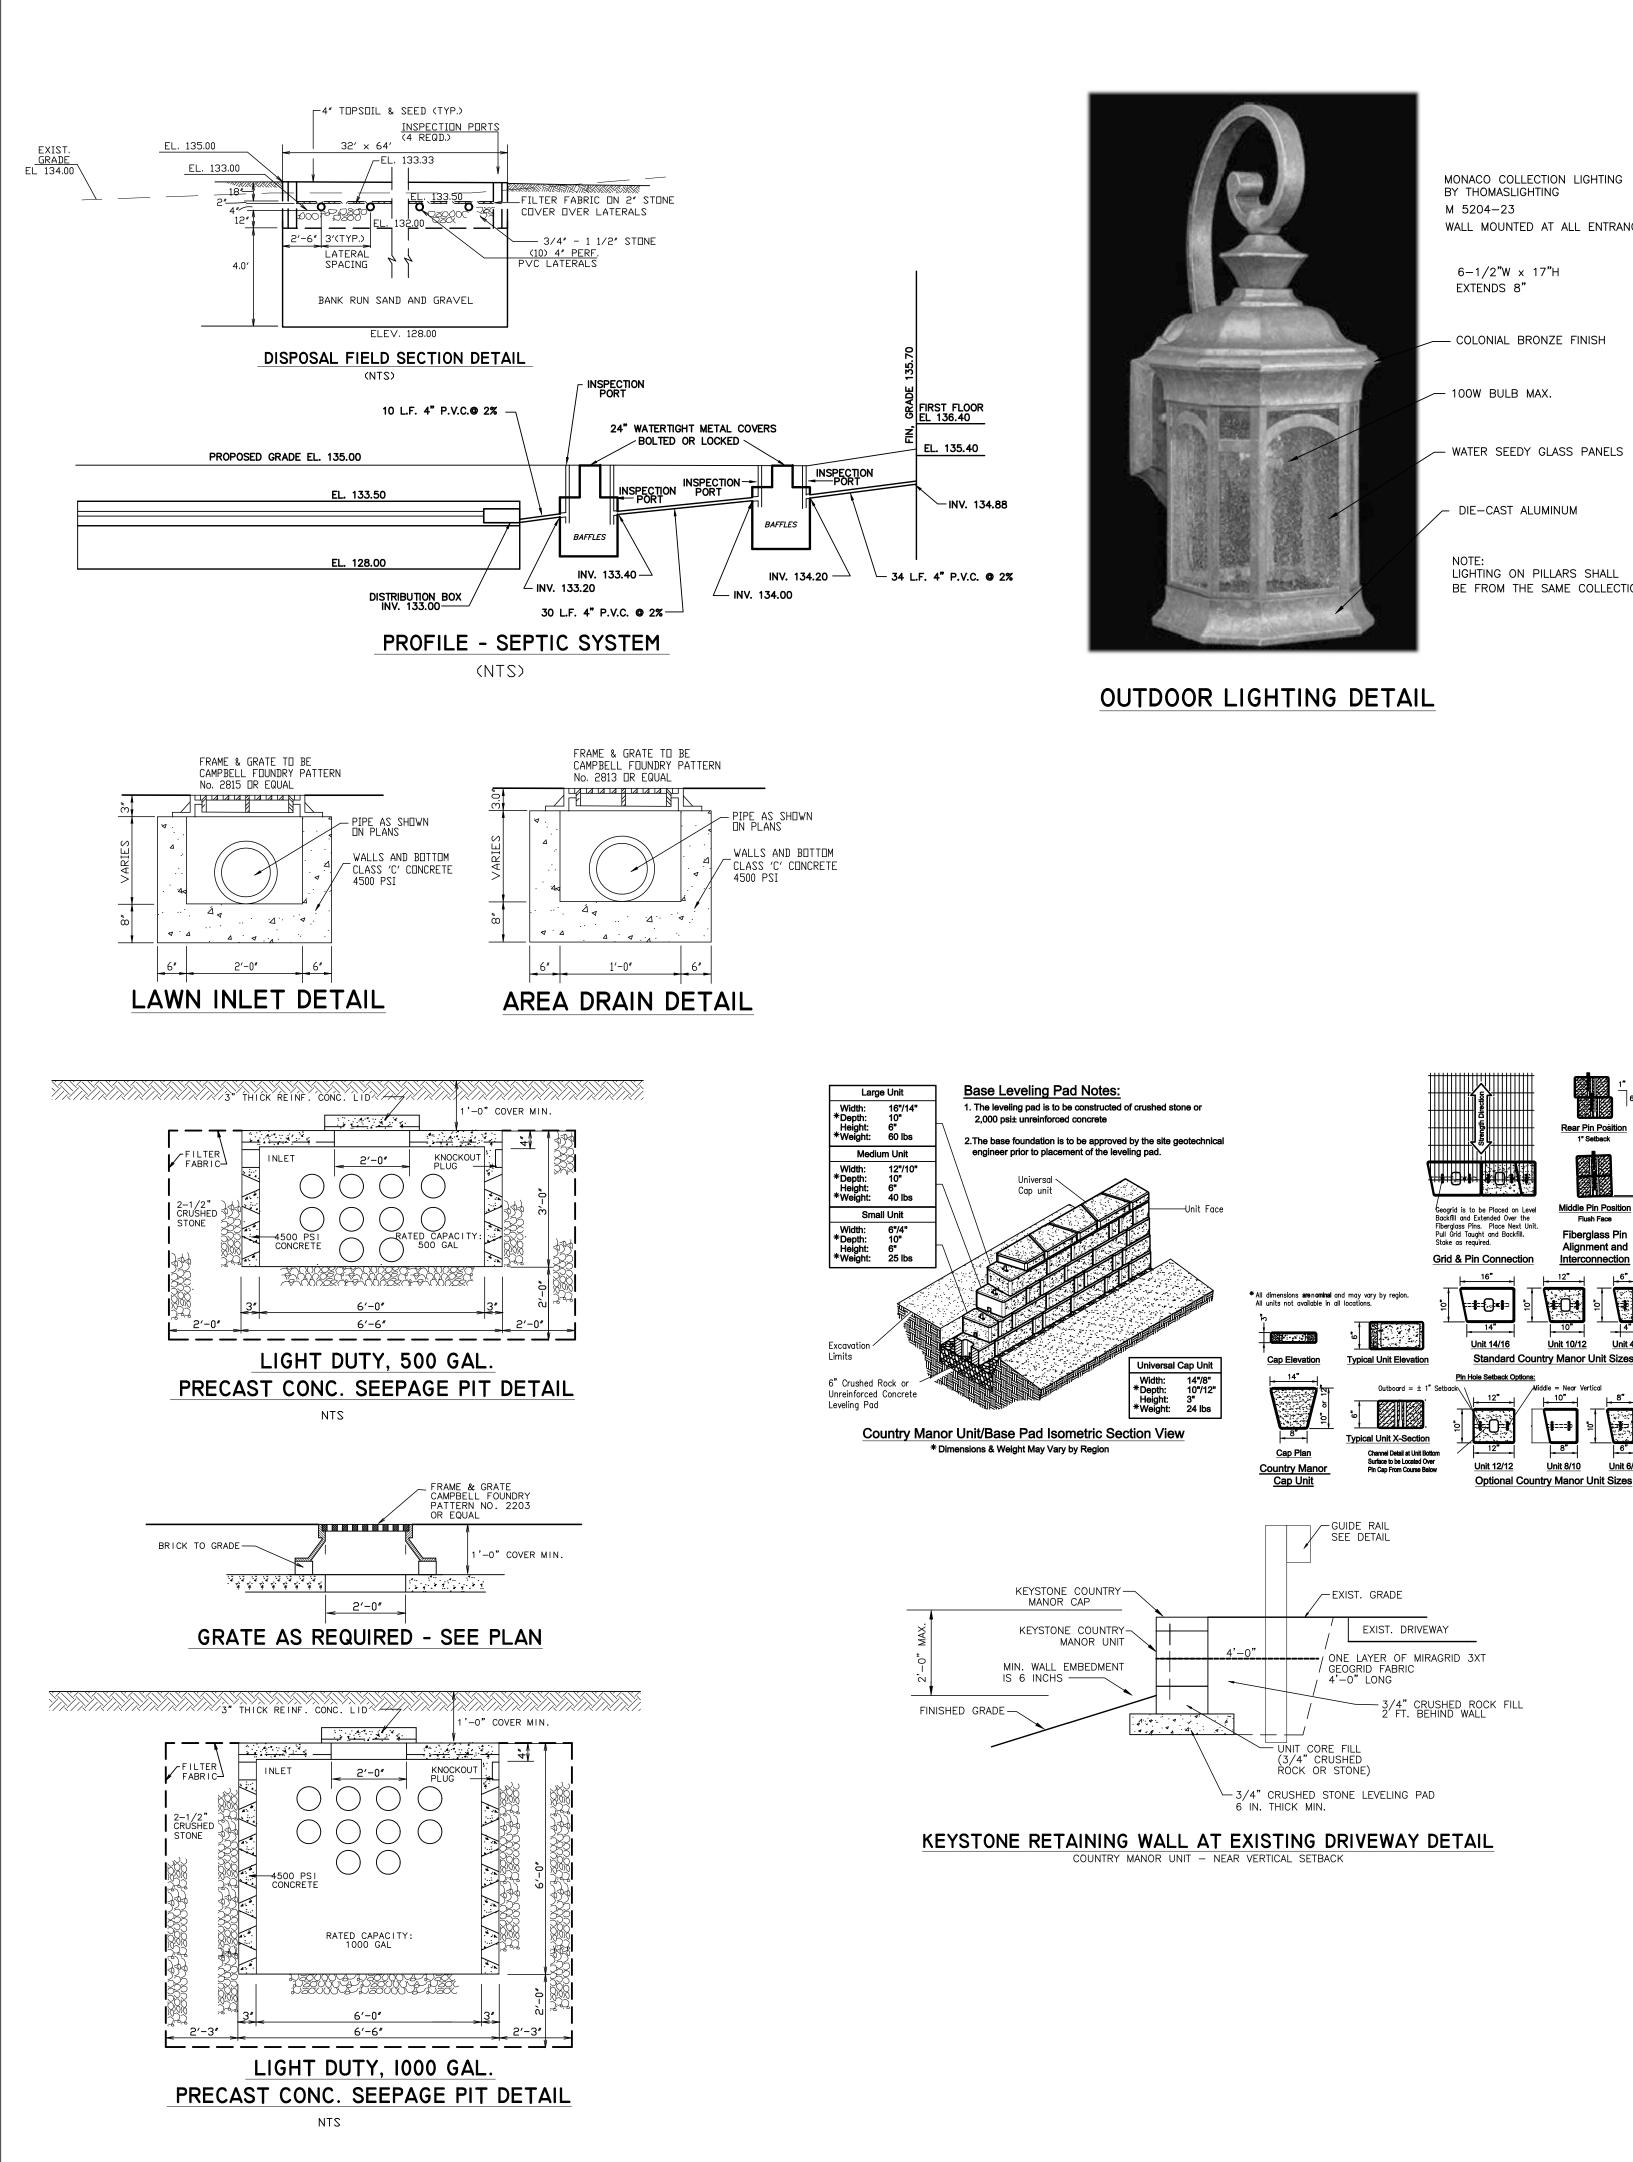


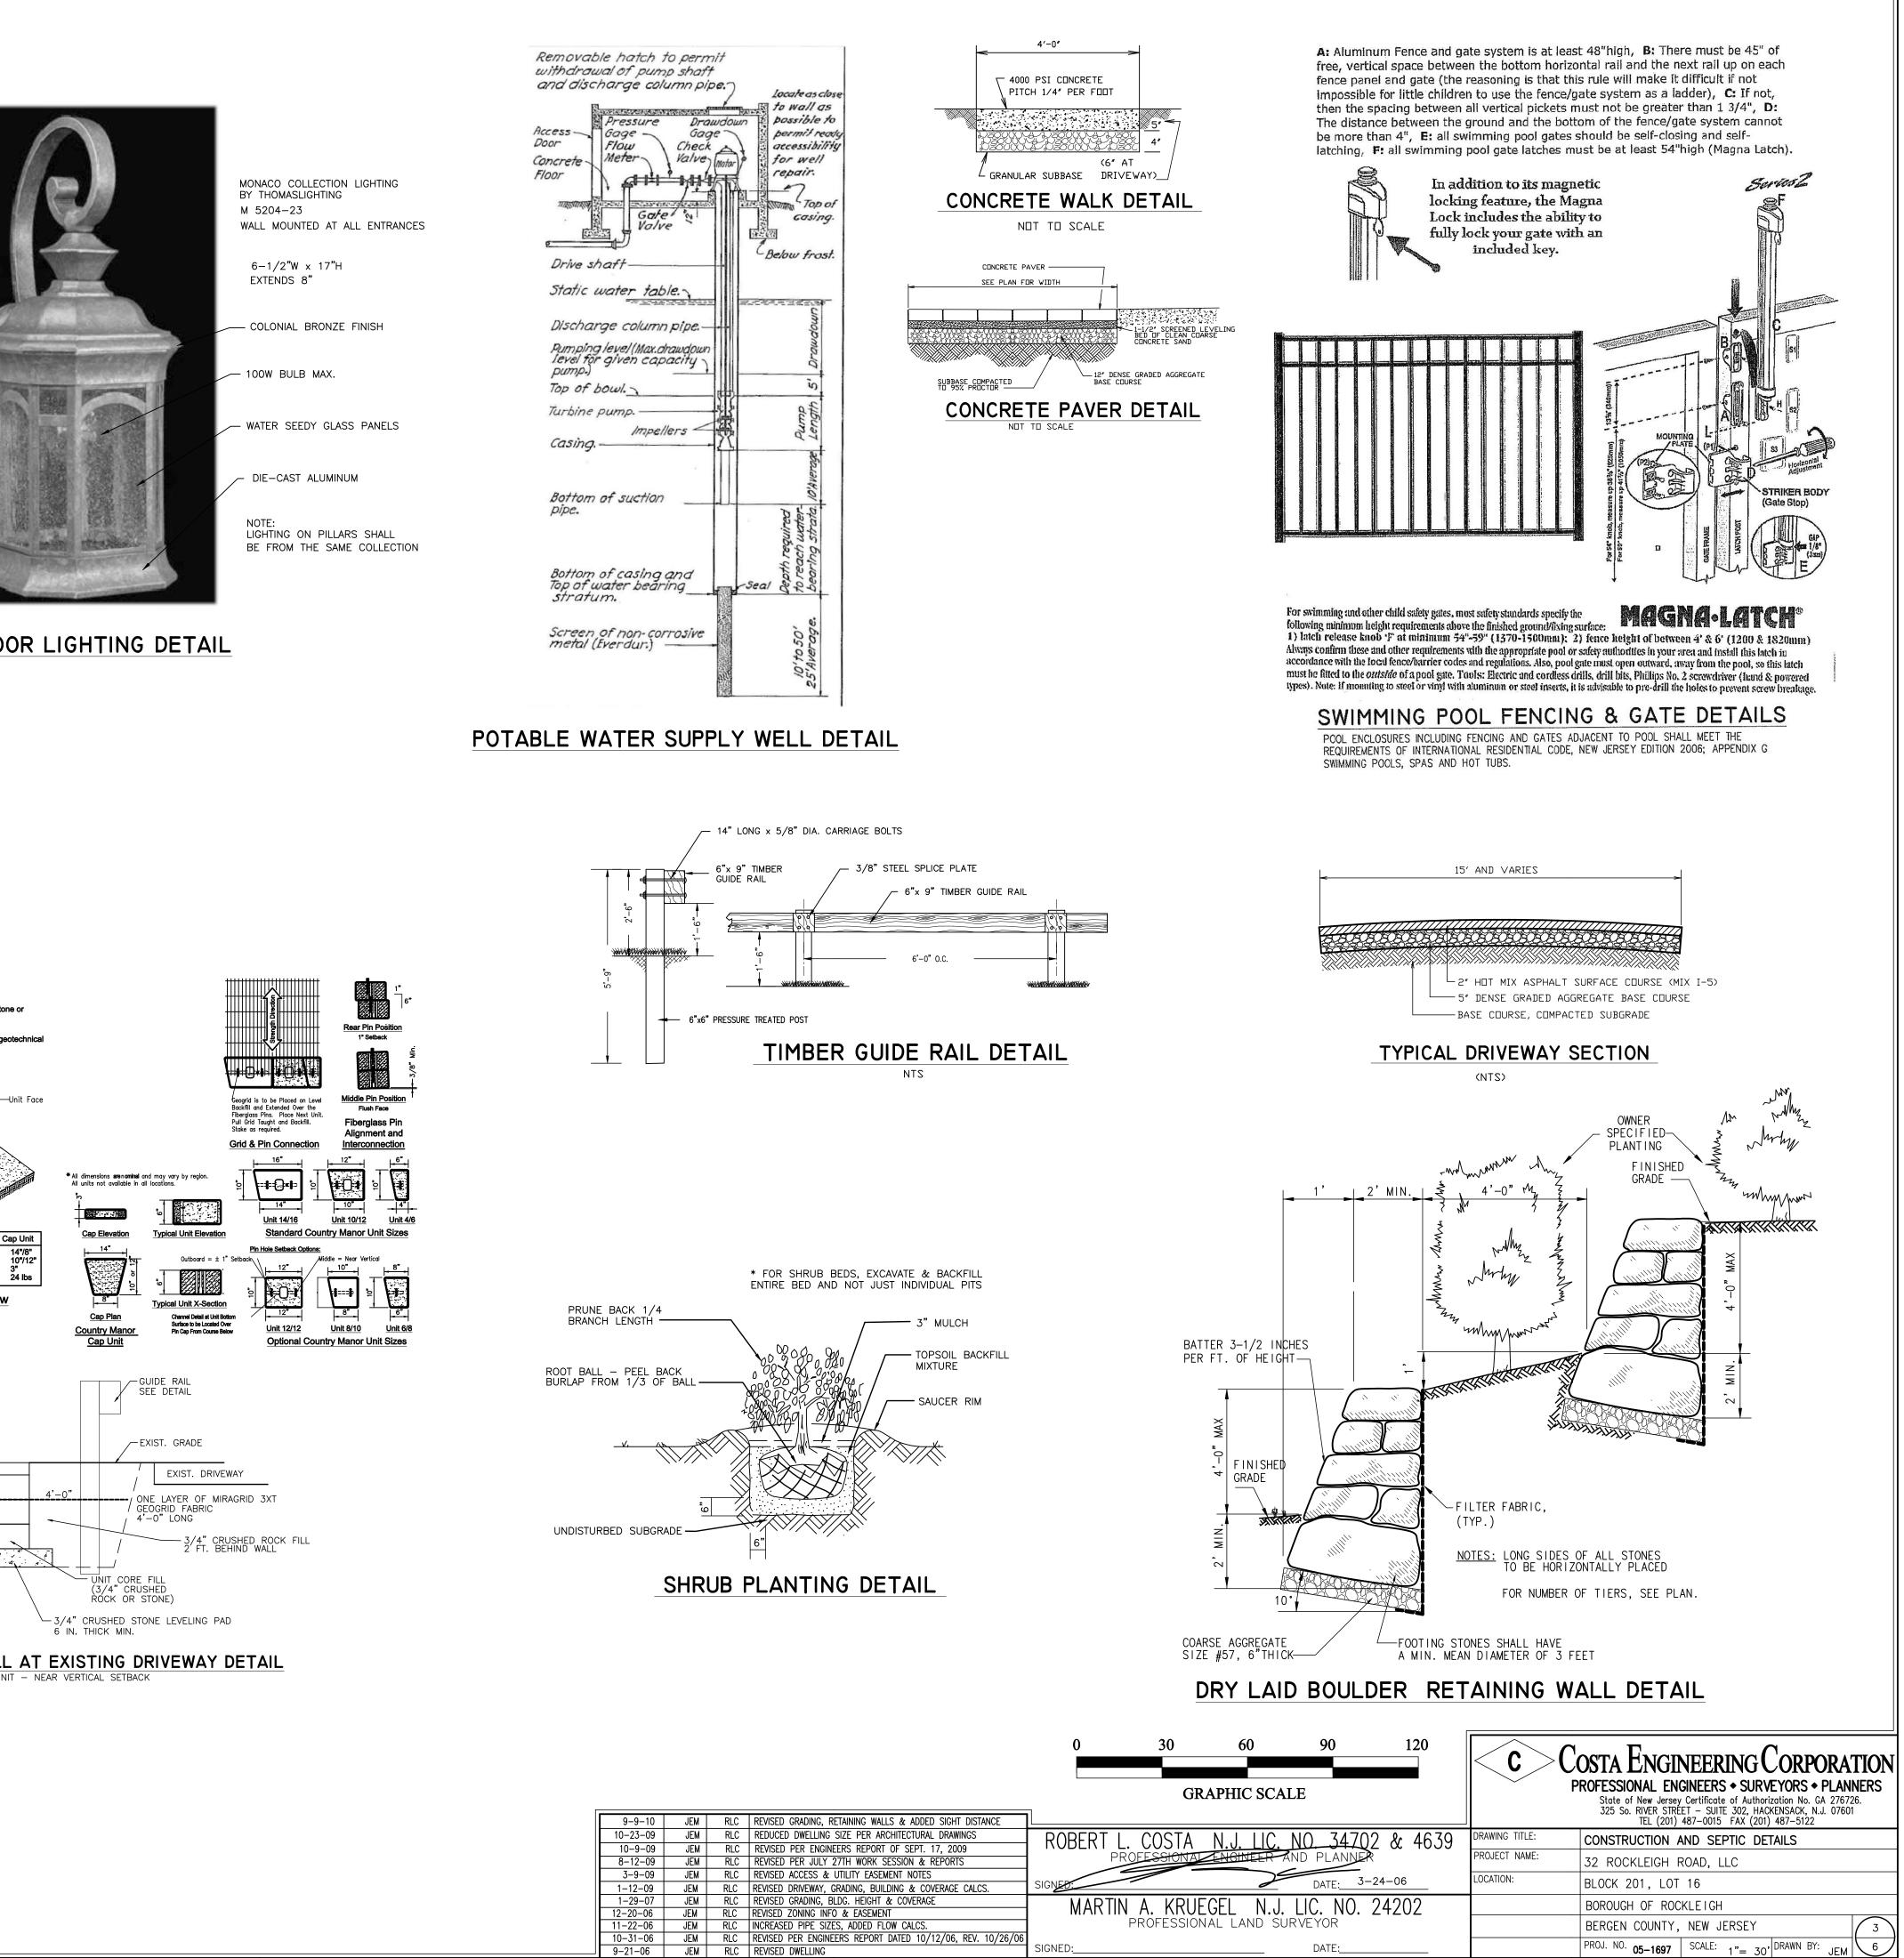


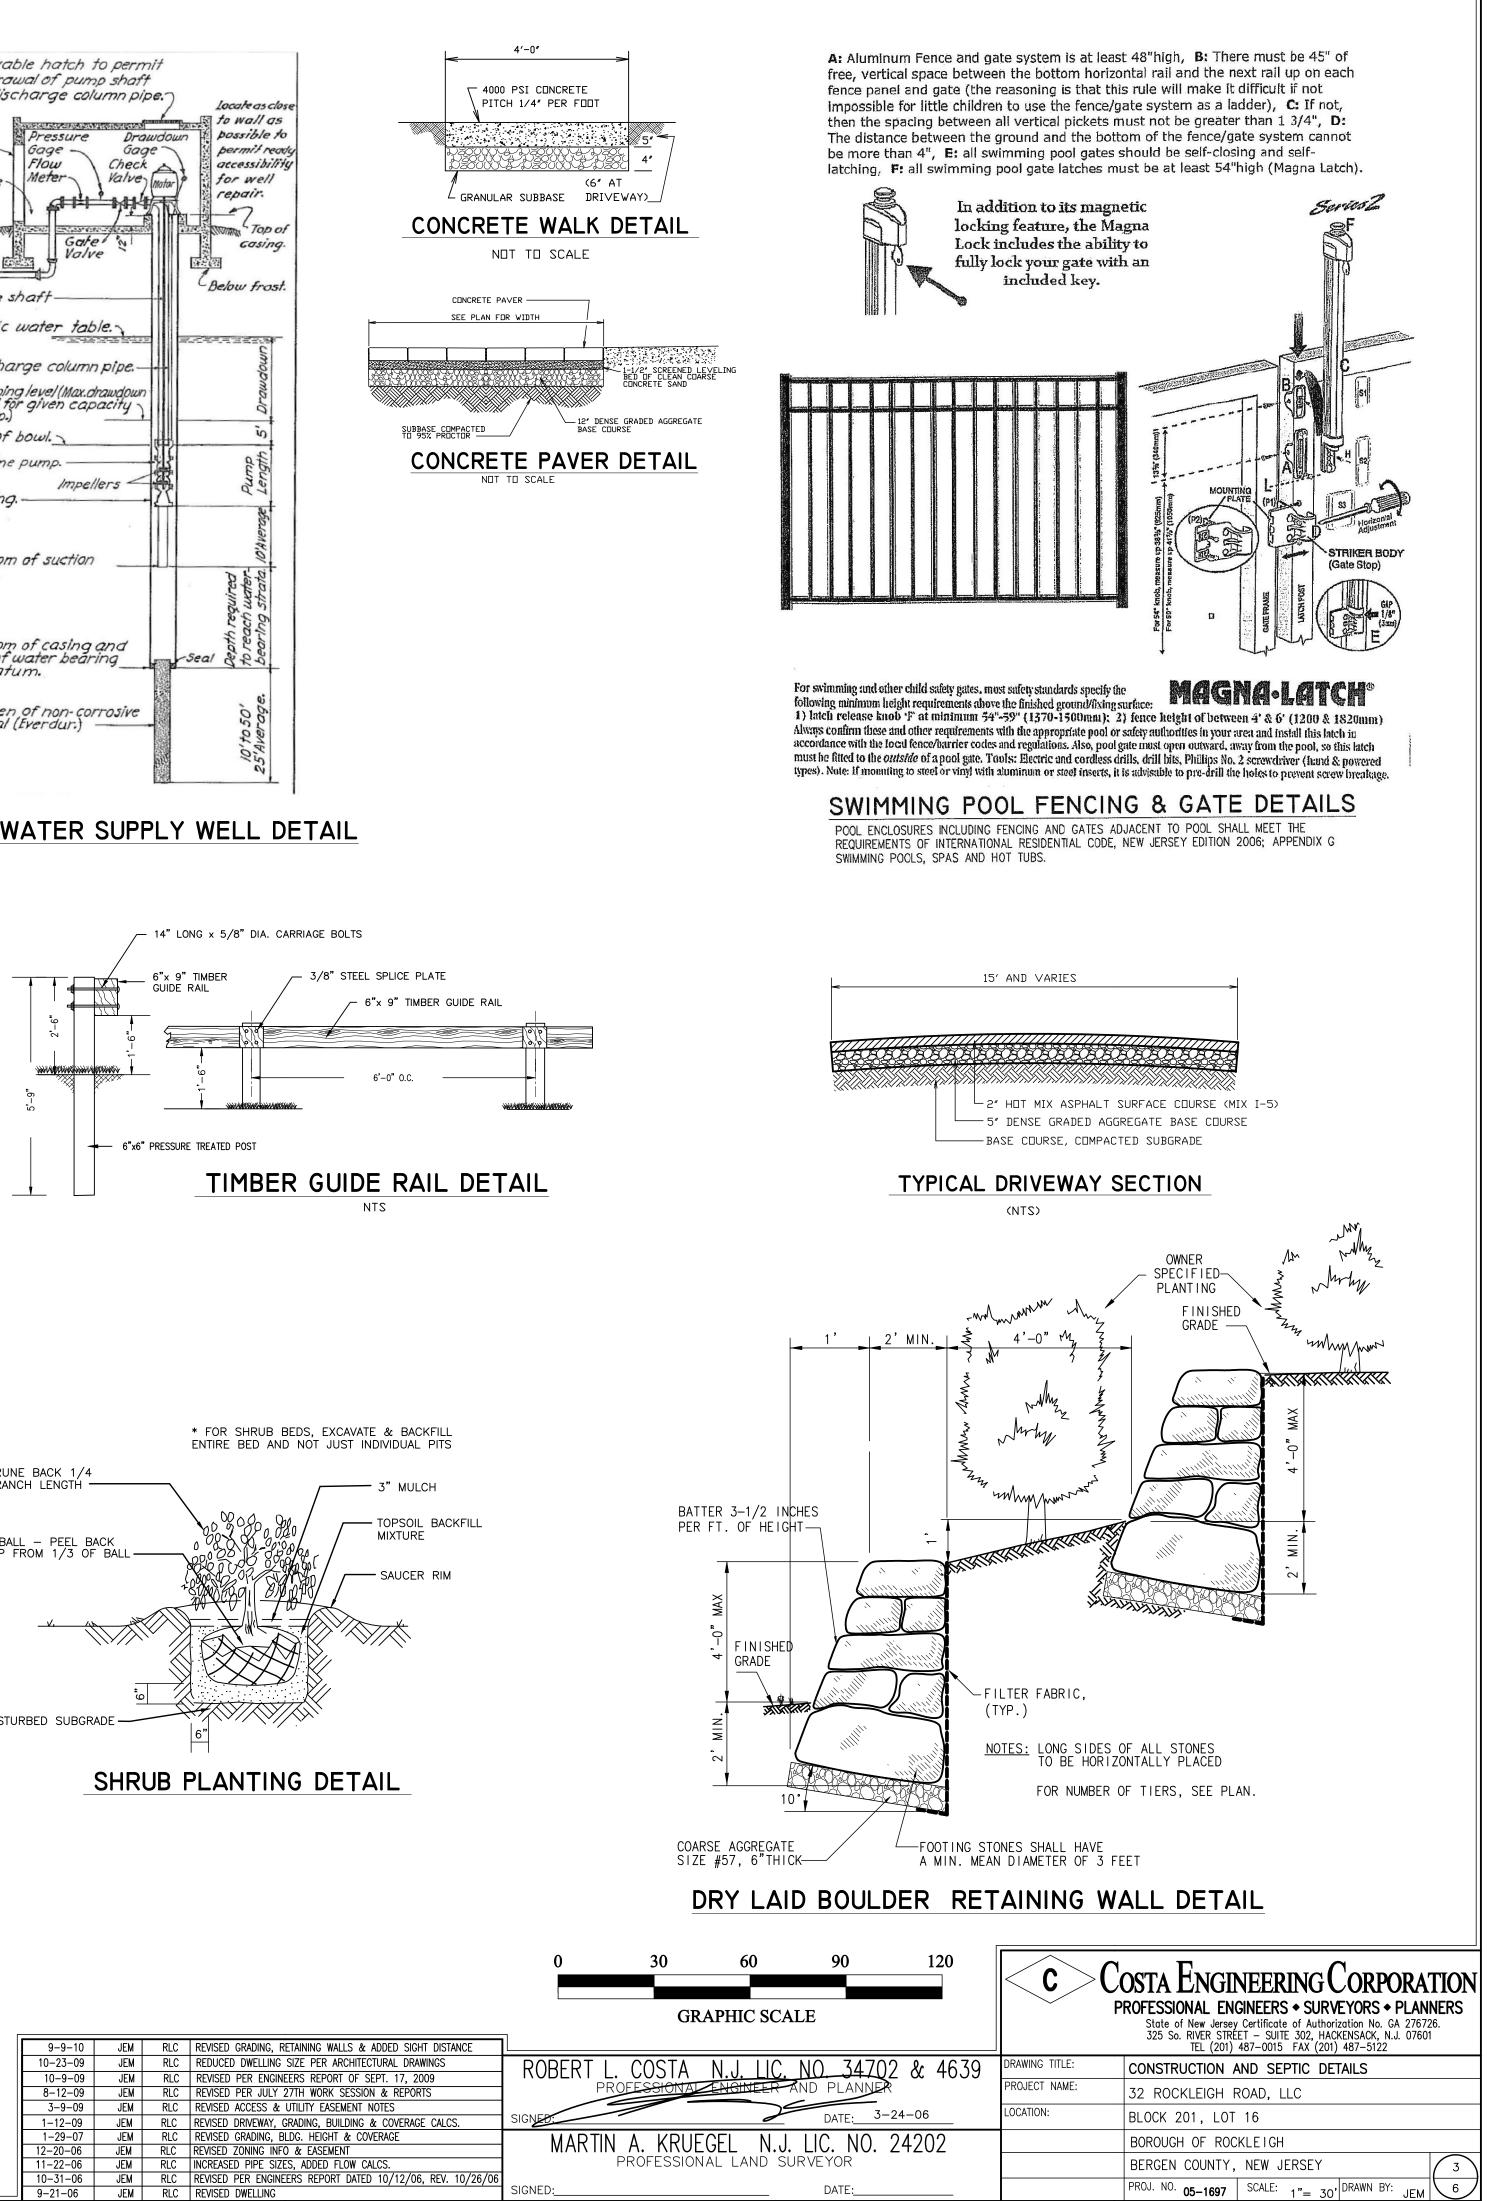


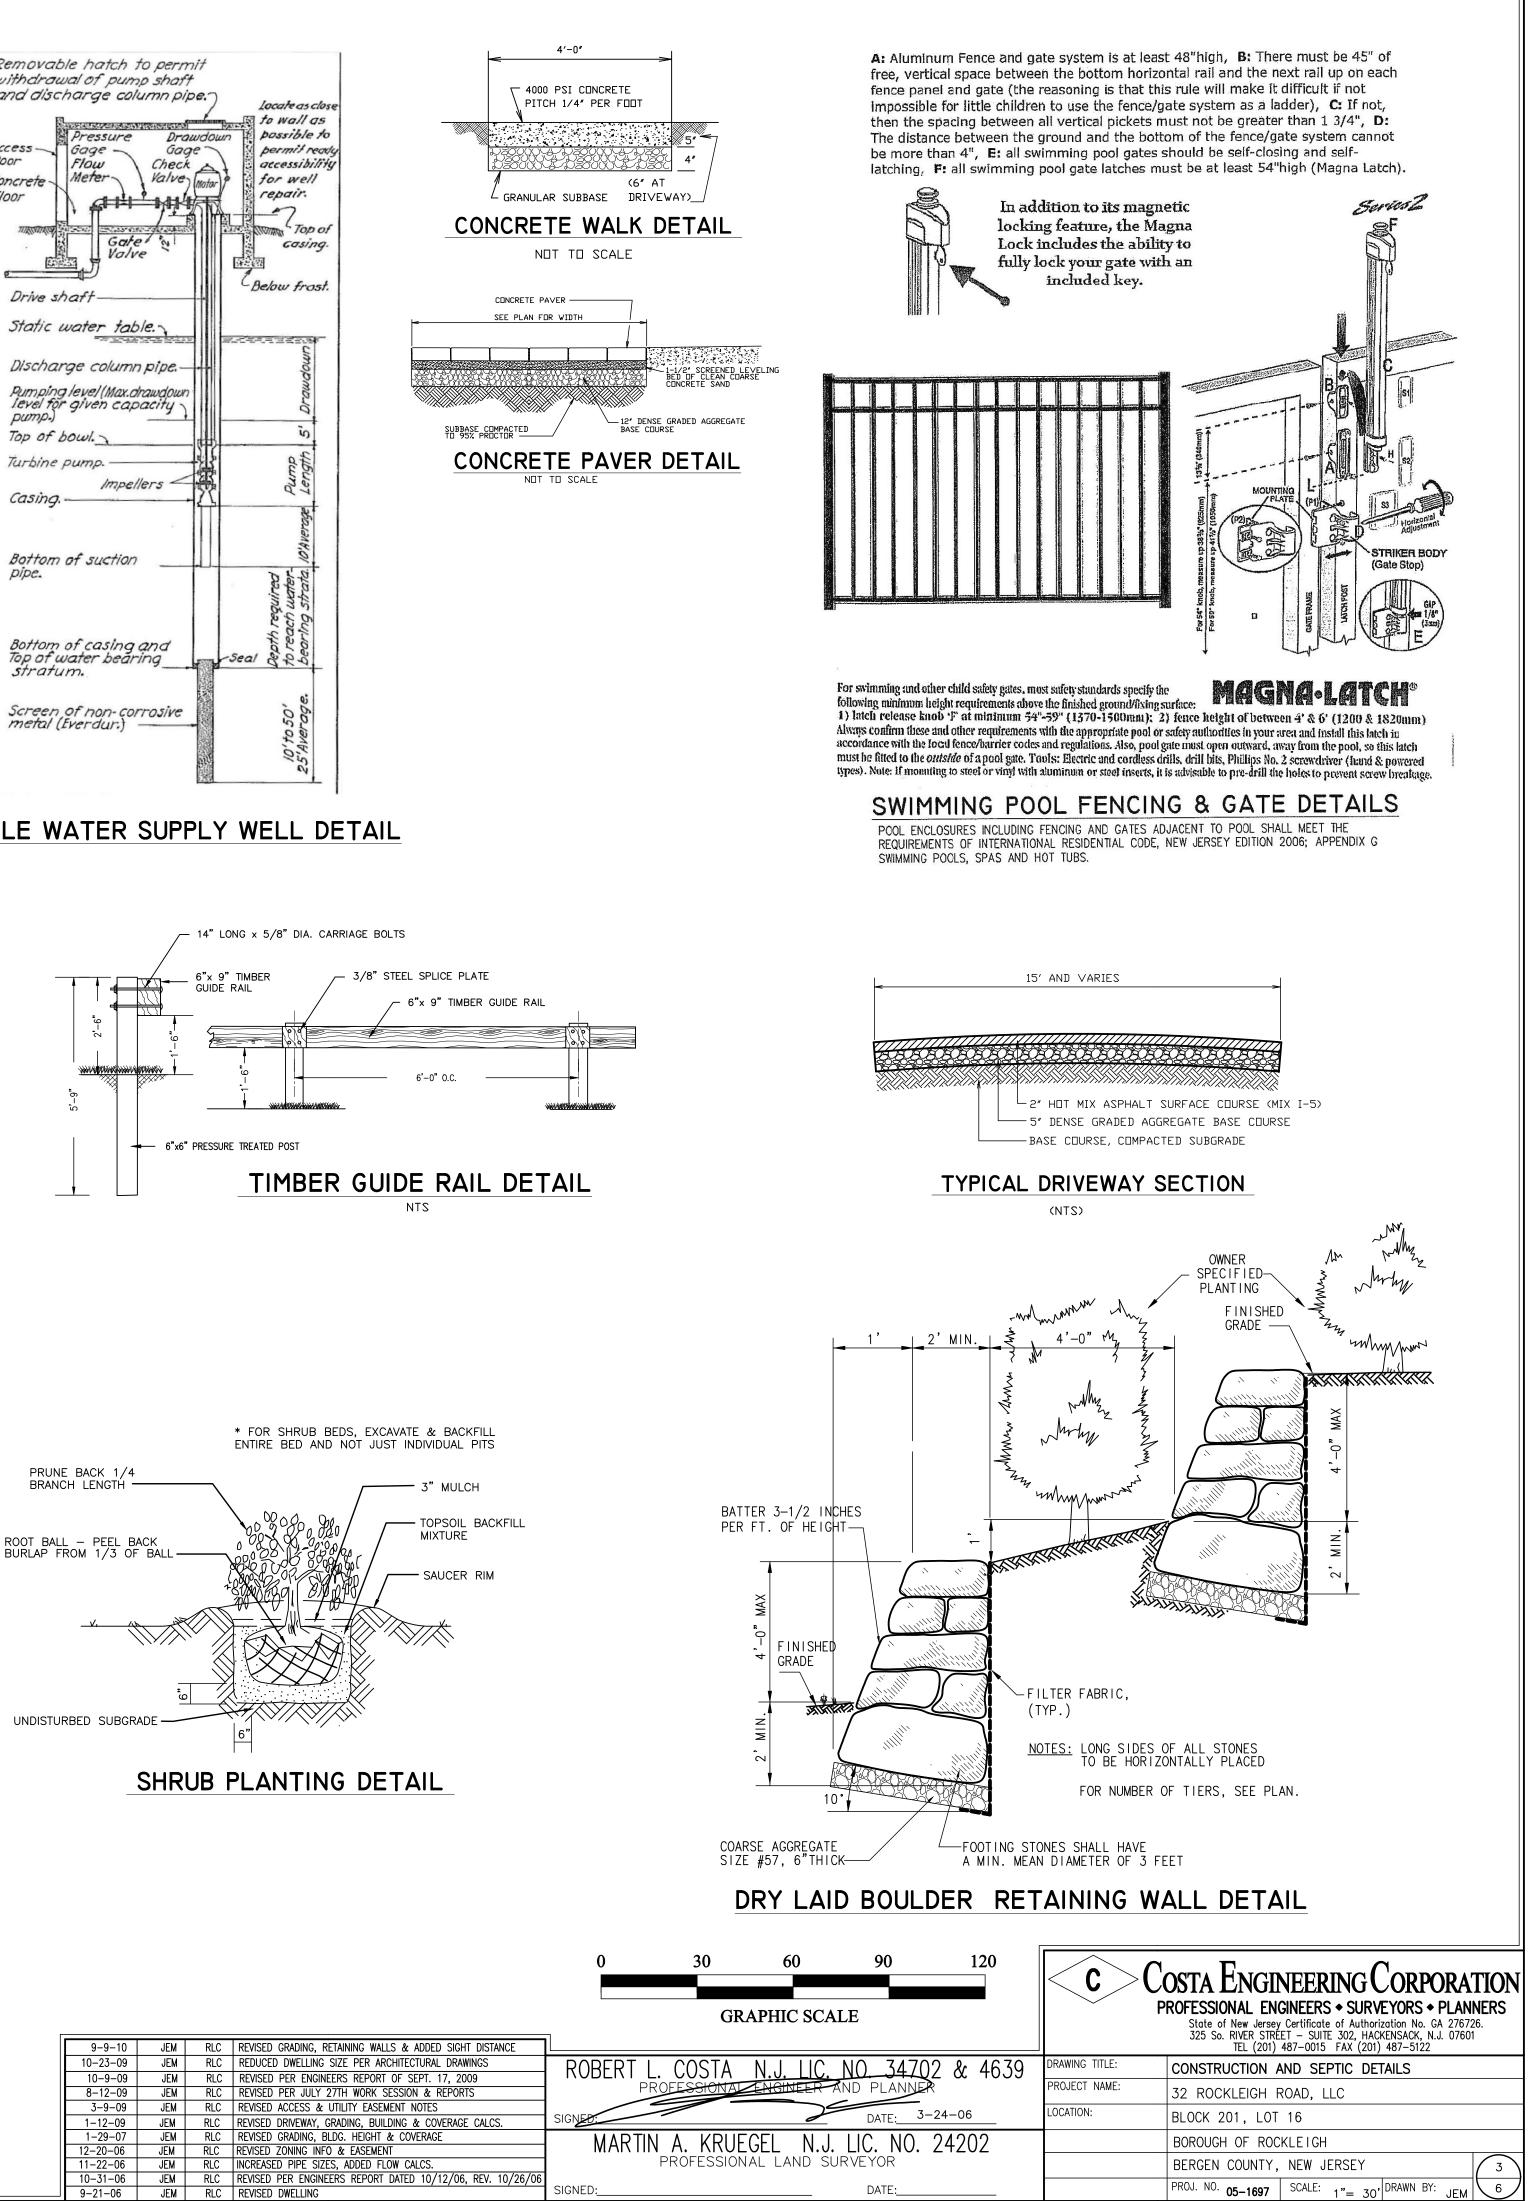



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	9-9-10	JEM	RLC	REVISED GRADING, RETAINING WALLS & ADDED SIGHT DISTANCE
	10-23-09	JEM	RLC	REDUCED DWELLING SIZE PER ARCHITECTURAL DRAWINGS
	10-9-09	JEM	RLC	REVISED PER ENGINEERS REPORT OF SEPT. 17, 2009
	8-12-09	JEM	RLC	REVISED PER JULY 27TH WORK SESSION & REPORTS
	3-9-09	JEM	RLC	REVISED ACCESS & UTILITY EASEMENT NOTES
	1-12-09	JEM	RLC	REVISED DRIVEWAY, GRADING, BUILDING & COVERAGE CALCS.
	1-29-07	JEM	RLC	REVISED GRADING, BLDG. HEIGHT & COVERAGE
	12-20-06	JEM	RLC	REVISED ZONING INFO & EASEMENT
	11-22-06	JEM	RLC	INCREASED PIPE SIZES, ADDED FLOW CALCS.
	10-31-06	JEM	RLC	REVISED PER ENGINEERS REPORT DATED 10/12/06, REV. 10/26
	9-21-06	JEM	RLC	REVISED DWELLING

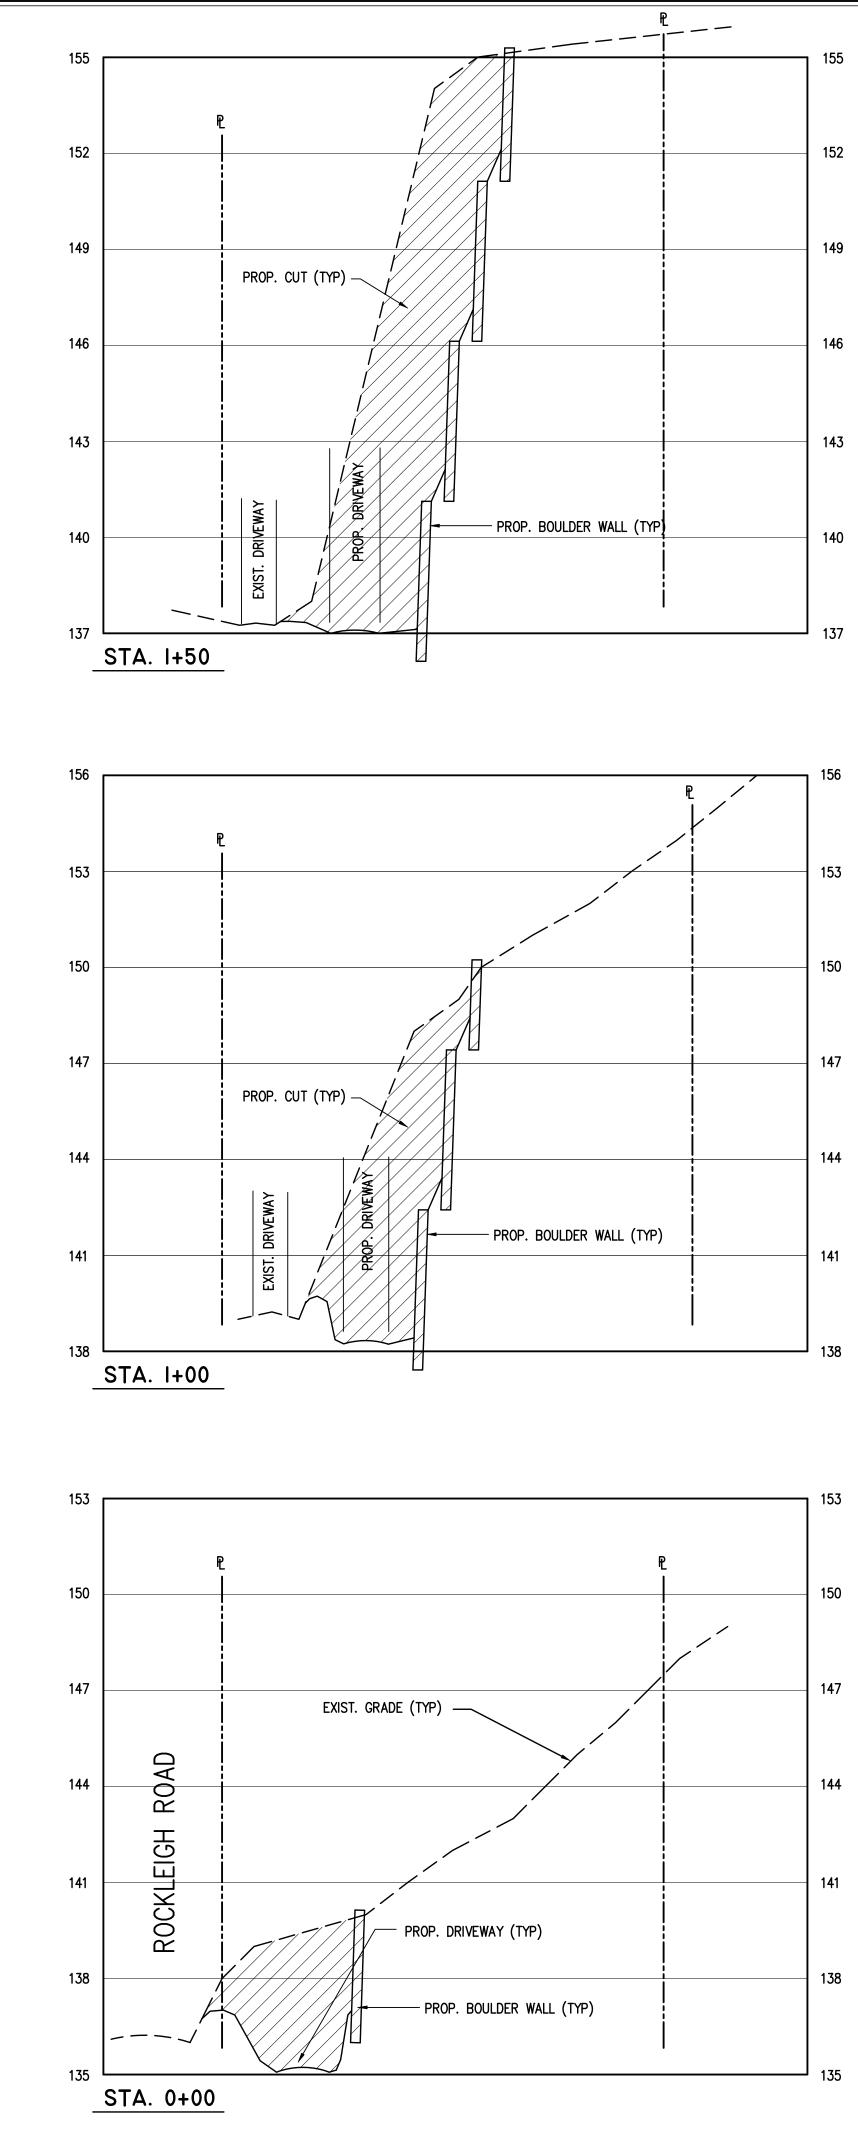


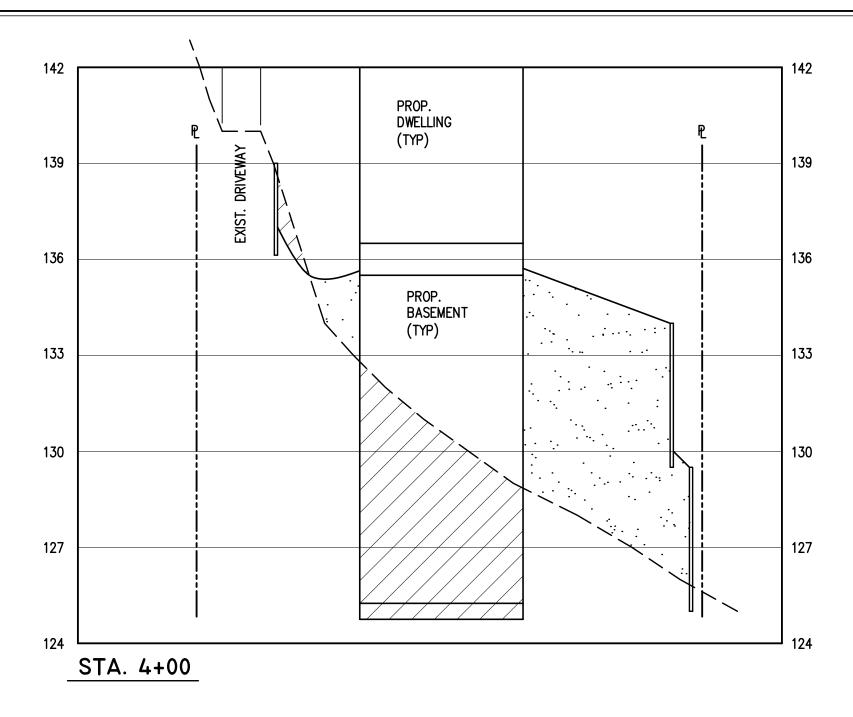

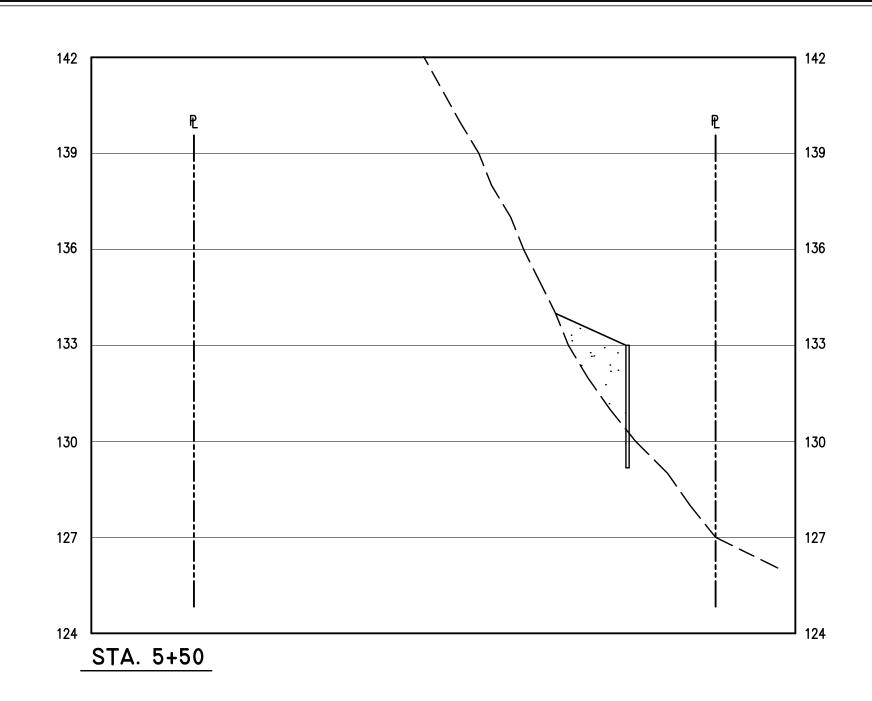

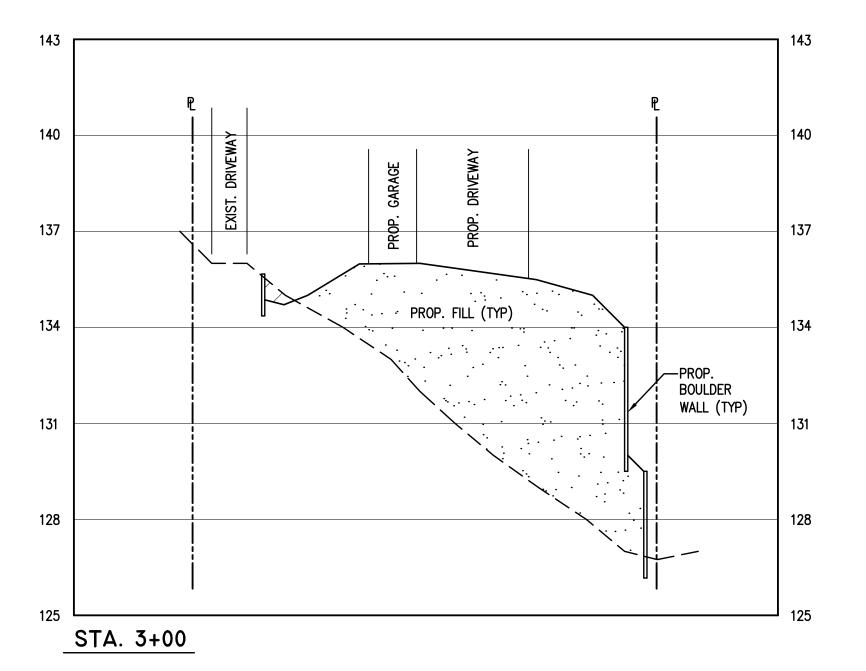

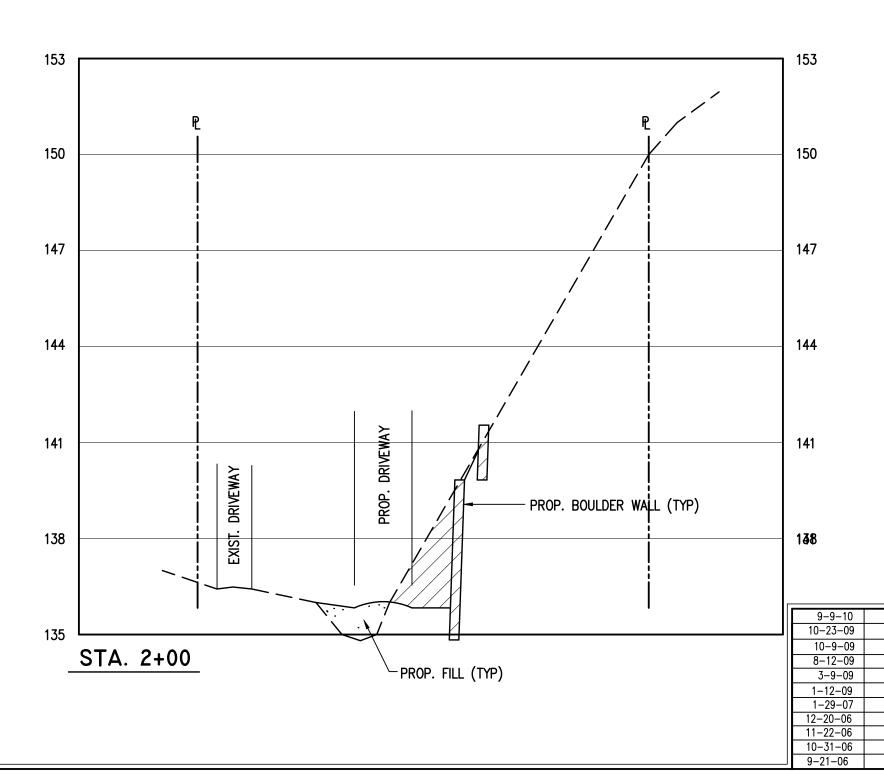


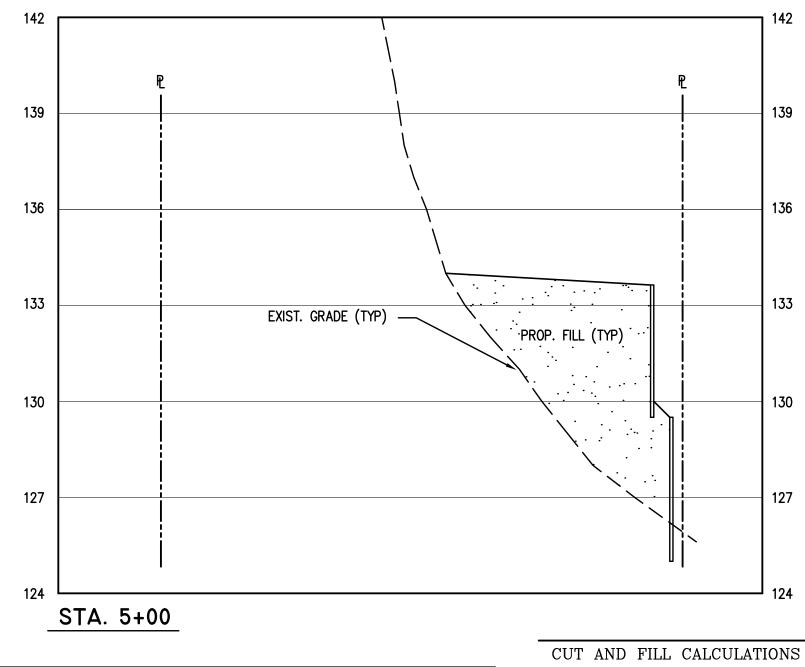

	SOIL N	IOVEMENT:	
		ROM SECTIONS: CU.YDS	
	VOLUM	IES BACKED OUT OF FILL FOR SEEPAGE PITS A	ND :
	SEEPA	GE PITS: = 26 CU.YDS. x (7) 1,000 GAL. PITS 16 CU.YDS. x (1) 500 GAL. PIY =	
	SEPT	C SYSTEM: IC TANKS = 8 CU.YDS. x (2) TANKS = 16 CU. DSAL FIELD = 32 x 64 x 5.0 = 379 CU.YDS.	YDS.
	TOTAL	TO BACK OUT = 593 CU.YDS.	
	NET M	IOVEMENT:	
		FILL = 3,435 CU.YDS. CUT = 3,501 CU.YDS.	
	to be	EXPORTED = 66 CU.YDS. OF SOIL	
	114 CI	EPTIC SYSTEM: J.YDS. OF 3/4 TO 1–1/2" STONE IS REQUIRED U.YDS. OF BANK RUN SAND & GRAVEL IS REQ	
		SCALE: HORIZ. 1"= 30' VERT: 1"= 3'	7
JEM	RLC	REVISED GRADING, RETAINING WALLS & ADDED SIGHT DISTANCE REDUCED DWELLING SIZE PER ARCHITECTURAL DRAWINGS	
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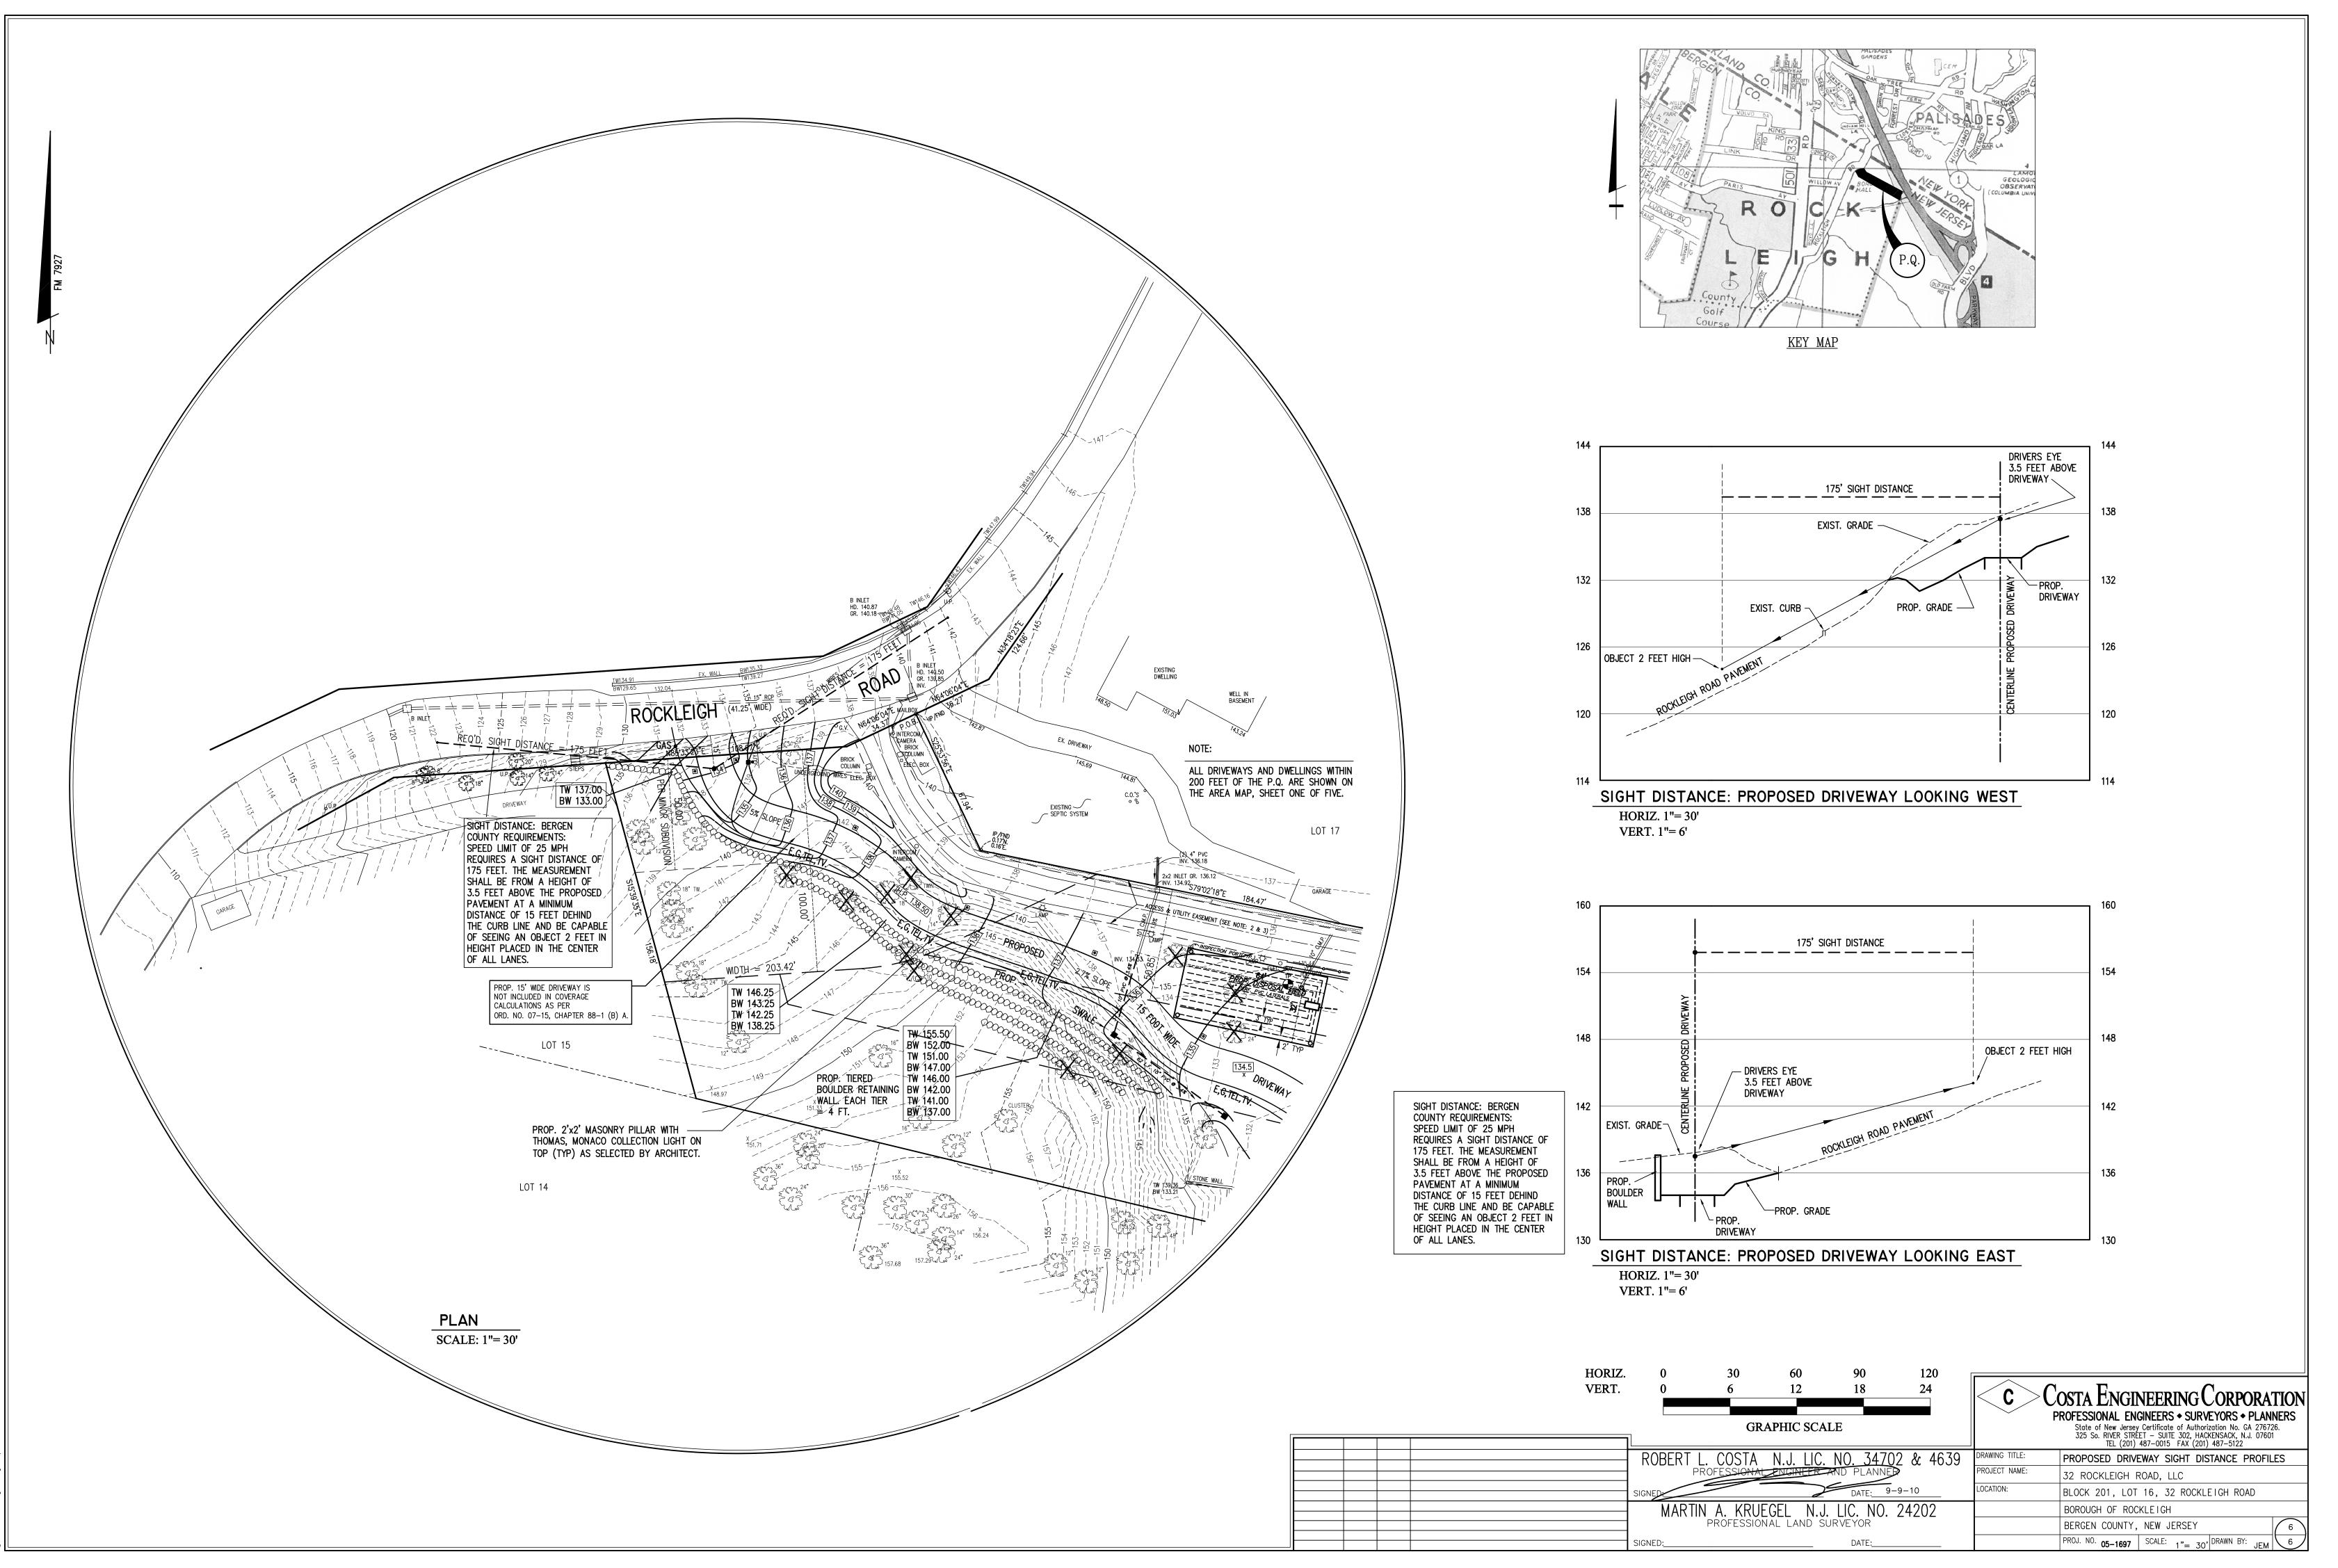
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					(FROM SECT			
	STATION	DISTANCE	CUT S.F.	FILL S.F.	AVG. CUT S.F.	AVG. FILL S.F.	CUT CU.FT.	FILL CU.FT.
			-					
	0-40		0	0				
SEPTIC SYSTEM:	0+00	40	160	0	80	0	3,200	0
182 CU.YDS.	1+00	- 100	278	0	219	0	21,900	0
CU.YDS.	1+50	- 50	537	0	407.5	0	20,375	0
	2+00	- 50	55	17	296	8.5	14,800	425
S.	3+00	100	4	480	29.5	248.5	2,950	24,850
	4+00	100	311	382	157.5	431	15,750	43,100
	5+00	100	0	270	155.5	326	15,550	32,600
[5+50	- 50	0	34	0	152	0	7,600
		- 10		-	0	17	0	170
	5+60	-	0	0	-			
						TOTAL	94,525 CUFT	108,745 CUFT
						TOTAL	3,501 CUYDS	4,028 CUYDS
ID ED								
0 30	60	90		120	C	-Costa]	NCINE	
								ERS + SURVEY(
GR	RAPHIC SCA	LE				State of	New Jersey Certifi RIVER STREET - S	icate of Authorizatic SUITE 302, HACKENS 015 FAX (201) 487
ROBERT L. COSTA	A N.J. LI(C. NO	34702 0	& 4639	DRAWING TITLE:	SOIL MO	VEMENT SEC	
PROFESSION	ALENGINEE	AND PL	ANNER	-	PROJECT NAME:	32 ROCI	KLEIGH ROAD	, LLC

	5+50 5+60	- 50 - 10	- 0	34 0	0	152 17 TOTAL TOTAL	0 0 94,525 CUFT 3,501 CUYDS	7,600 170 108,745 CUFT 4,028 CUYDS		
0 AND OUIRED 0 30	60	90		120		0	· 			
	HIC SCA				C	PROFESSIO	NAL ENGINE		DRPORATION ORS • PLANNERS on No. GA 276726. SACK, N.J. 07601 7-5122	
ROBERT L. COSTA N.J. LIC. NO. 34702 & 4639						SOIL MOVEMENT SECTIONS				_
PROFESSIONAL ENGINEER AND PLANNER					PROJECT NAME:		32 ROCKLEIGH ROAD, LLC			
					LOCATION.		BLOCK 201, LOT 16			
MARTIN A. KRUEGEL N.J. LIC. NO. 24202 PROFESSIONAL LAND SURVEYOR							BOROUGH OF ROCKLEIGH BERGEN COUNTY, NEW JERSEY			$\overline{}$
SIGNED:		DAT				PROJ. NO.	-	LE: 1"= 30' DR/	AWN BY: JEM 6	$\overline{)}$

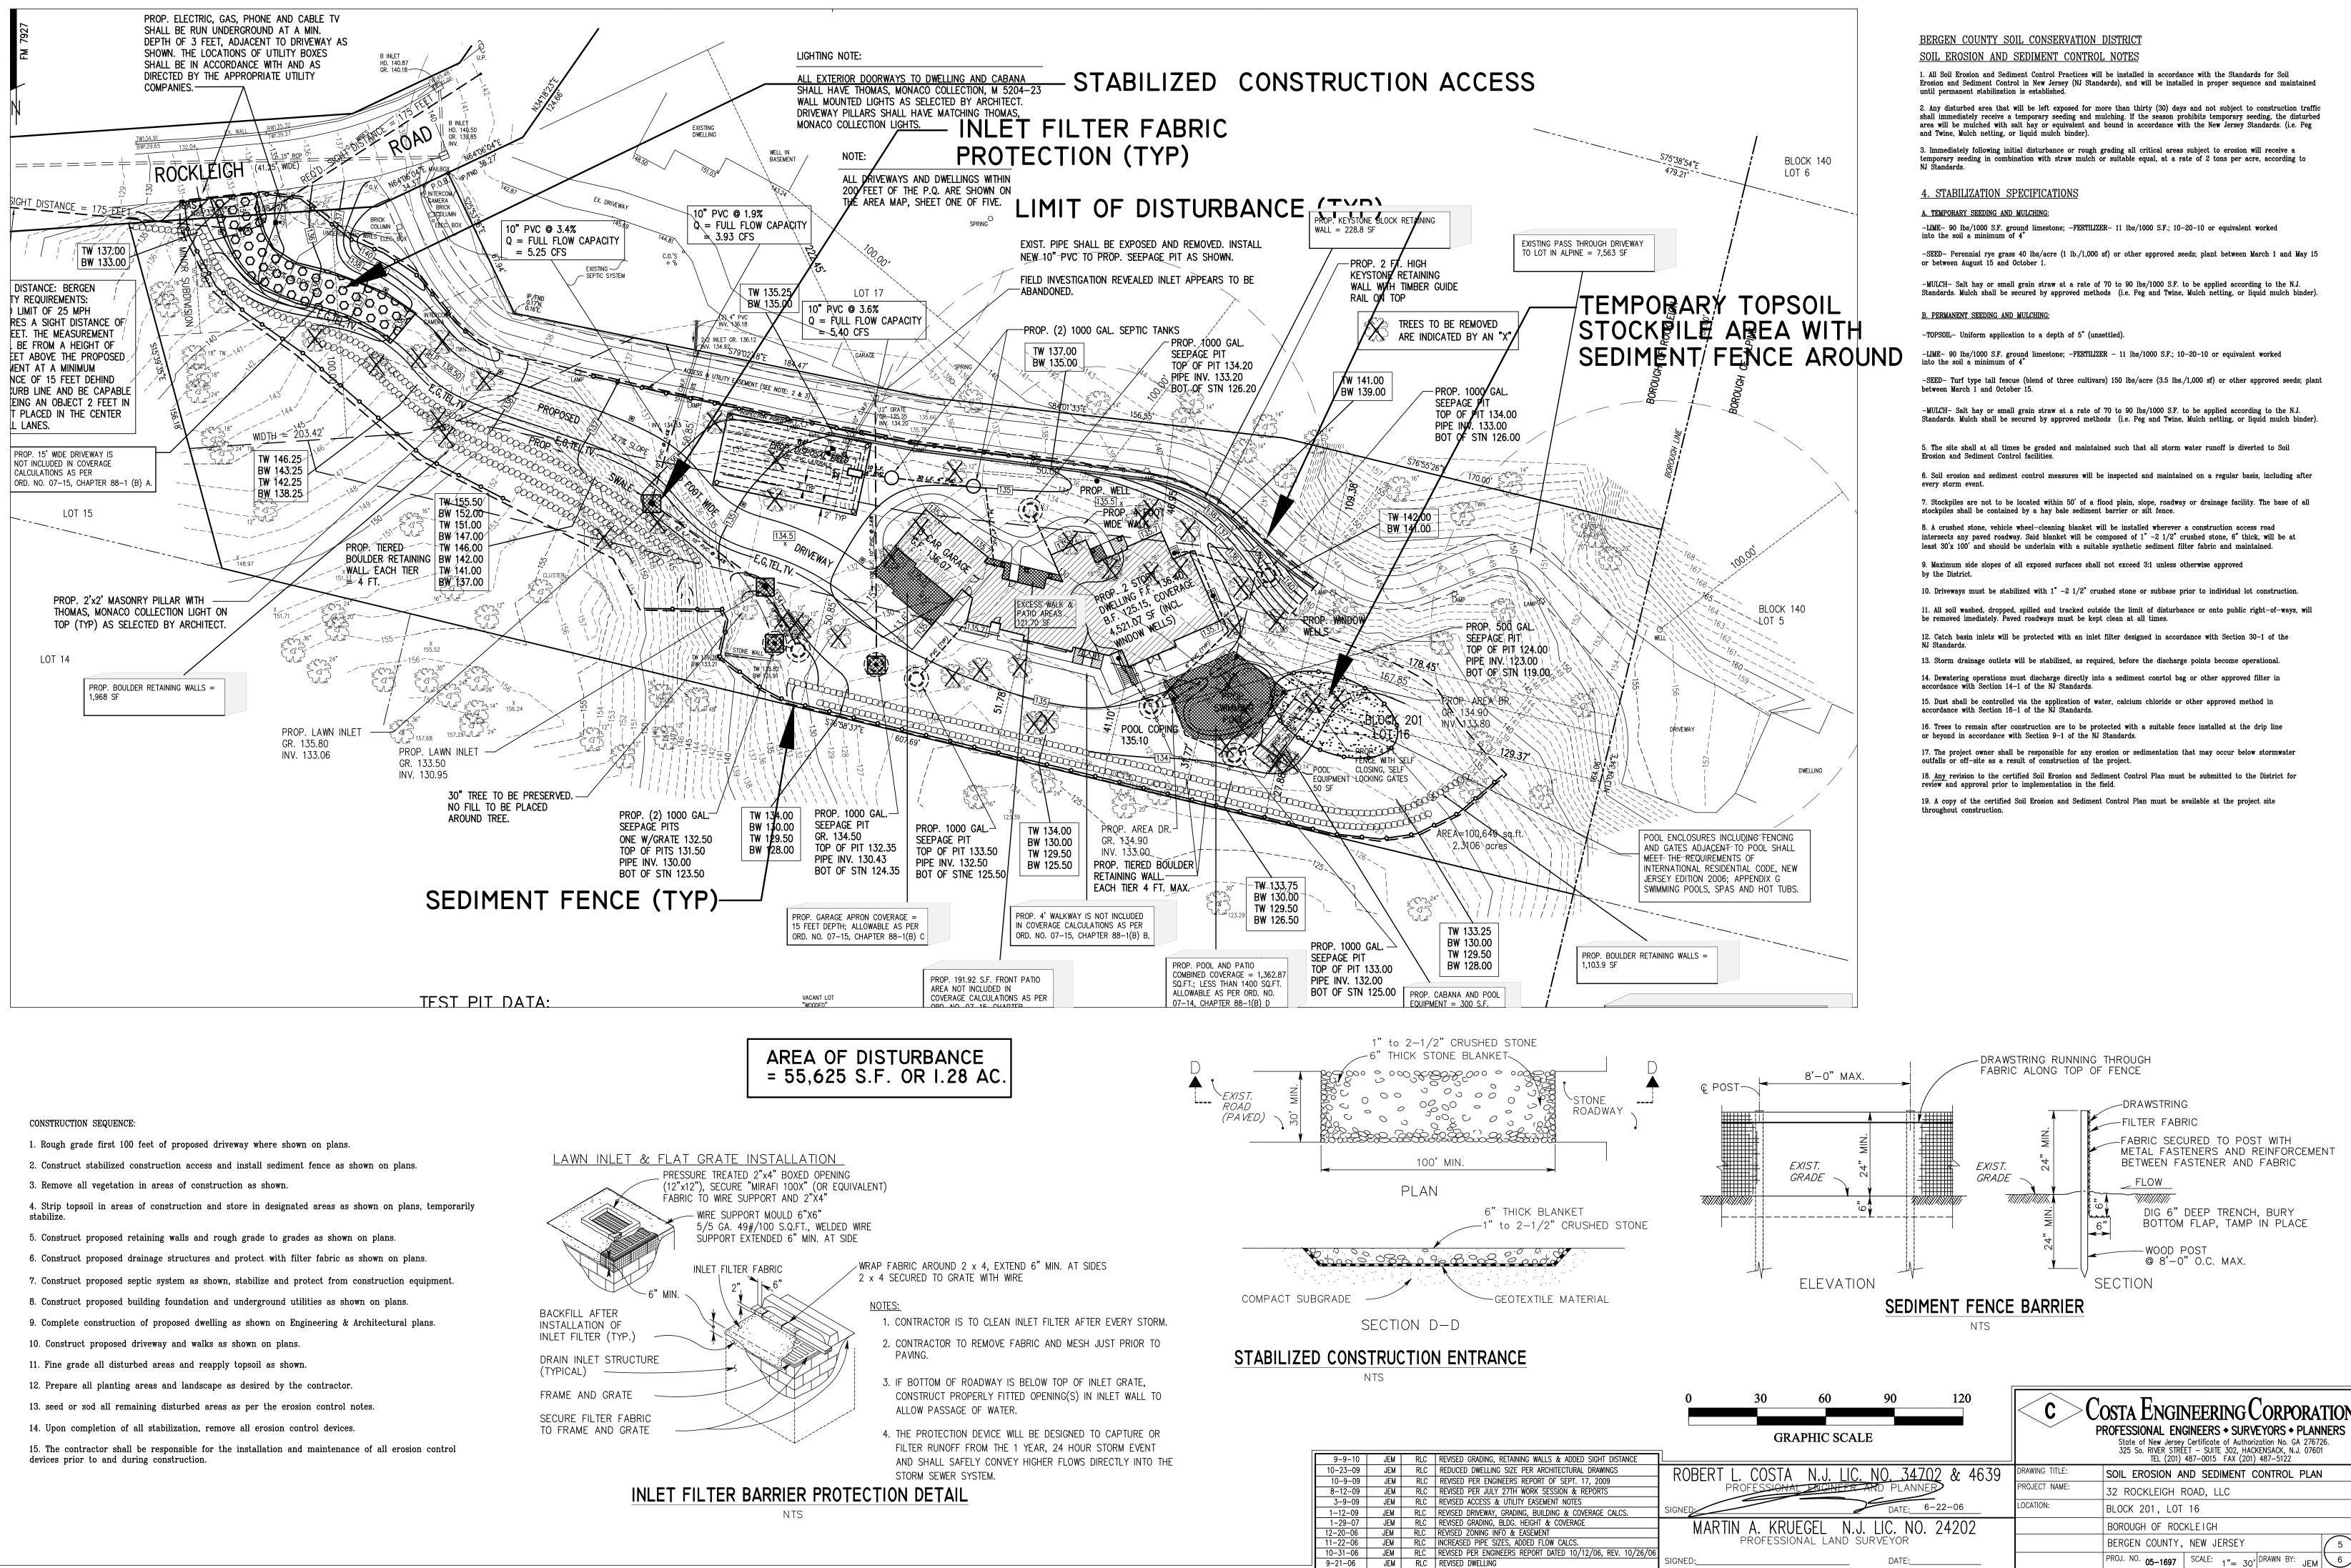

SIGNED:

PROJ. NO. 05-1697 SCALE: 1"= 30'DRAWN BY: JEM 16



2006 Costa Engineering Cor